

5-24-13 PLANS APPROVAL DATE

COUNTY OF EL DORADO PLACERVILLE, CA. 95667

The state of California or its officers or agents shall not be responsible for the accuracy or completeness of electronic copies of this plan sheet

																													сор
PLAN SHEET NO.	SYSTEM NO.	DRAINAGE UNIT	TYPE OS INLET	TYPE G3 INLET	TYPE GO INLET	12" PLASTIC PIPE	18" PLASTIC PIPE	36" DIA TYPE GMP INLET	18" METAL FES	48" DIA SD MANHOLE	49"x33" METAL FES	49"x33" CMP ARCH PIPE	PCC CONCRETE SLAB	#4 REBAR, 18" OC EACH WAY	MINOR CONCRETE BACKFILL	RSP (No.1)	RSP FABRIC	REMOVE DRAINAGE INLET	REMOVE (E) 18" SD PIPE	REMOVE (E) 12" SD PIPE	REMOVE 33x49 CMPA CULVERT	ABANDON 33x49 CMPA CULVERT	SAND BACKFILL	CALTRANS STANDARD PLAN OR DETAIL REFERENCES	SLOPE	STATION	DRAINAGE UNIT	SYSTEM NO.	PLAN SHEET NO.
		$\times$	EA	EA	EA	LF	LF	EA	EA	EA	EA	LF	CY	LB	CY	CY	SY	EA	LF	LF	-		CY						
		a	1				2																	D72		'PV' 6+56.50-34.61' LT	а		
		b			1																			D74B		'PV' 7+03.40-32.00' LT	b	] .	
D-1	1	С					93																		S=0.033		С	1	D-1
		d			1		1 11										-	-						D74B	S=0.12	'PV' 8+00-32.00' LT	d		
		e f					11	1																D75A	3-0.12	'PV' 8+00-45.58' LT	e f	1	
		g						'											76					DISK		REMOVE (E) 18" SD PIPE	g	1	
		h																1	'							REMOVE (E) SD INLET	h	1	
	$\vdash$	a														2	7	+ '-								KEMOVE (E) 3D INCET	a		
		Ъ							1								'-									'PV' 5+49.46-53.37' RT	b	1	
		С					33																		S=0.006		С	1	
		d								1																'PV' 5+77.92-36.47' RT	d		
		е				6																			S=0.51		е		
		f		1			005																	D73	0 0 000	'PV' 5+77.98-30' RT	f		
D-2	2	g					295			1															S=0.028	'PV' 8+72.72-47.39' RT	g	2	D-2
		h i					169			1															S=0.015	FV 8+72.72-47.39 KT	h i	ł	
		-					103			1															3-0.013	'PV' 10+42.53-58.47' RT	H		
		k					54																		S=0.011	1, 101,12,00 00,17 11	k	1	
		- 1			1																			D74B		'PV' 10+95.90-74.55' RT			
		m					20																		S=0.031		m		
		n			1																			D74B	0.000	'PV' 10+38.66-79.98' RT	n		
		0				99		1																D75 A	S=0.02	'DV' 10 - 70 05 40 75' LT	0	1	
	$\vdash$	p a														15	28							D75A		'PV' 10+38.25-42.35' LT	p a		
		Ь									1					13	20									'PV' 14+76.08-38.86' RT	b		
		c										115	13	700	42										S=0.005		С	1	
		d									1															'PV' 15+55.12-45.47' LT	d		
D-3	3	e														16	32										e	3	D-3
		Ţ																		8						DEMONE 77:40 OHD4	†	-	
		g																			20 10					REMOVE 33x49 CMPA REMOVE 33x49 CMPA	g h	-	
		h i																			'	43	25			ABANDON 33x49 CMPA	i n	1	
BID G	)   A A ! -	<del>, '</del>	4	1		105	678	2	1	7	2	115	13	700	42	33	67	1	76	8	30	43				ADMINDOR SOATS CIVILA	<del></del>		
חום (	VIAIN	шТ		1	4	105	0/0			3	2	113	انا	L/00	42	JJ	0/	<u> </u>	/0	<u> </u>	JU	40	20						

В

CALCULATED/ DESIGNED BY

COUNTY


DORADO


딥

BID QUANTITY


DRAINAGE QUANTITIES


D-4
SCALE: NONE

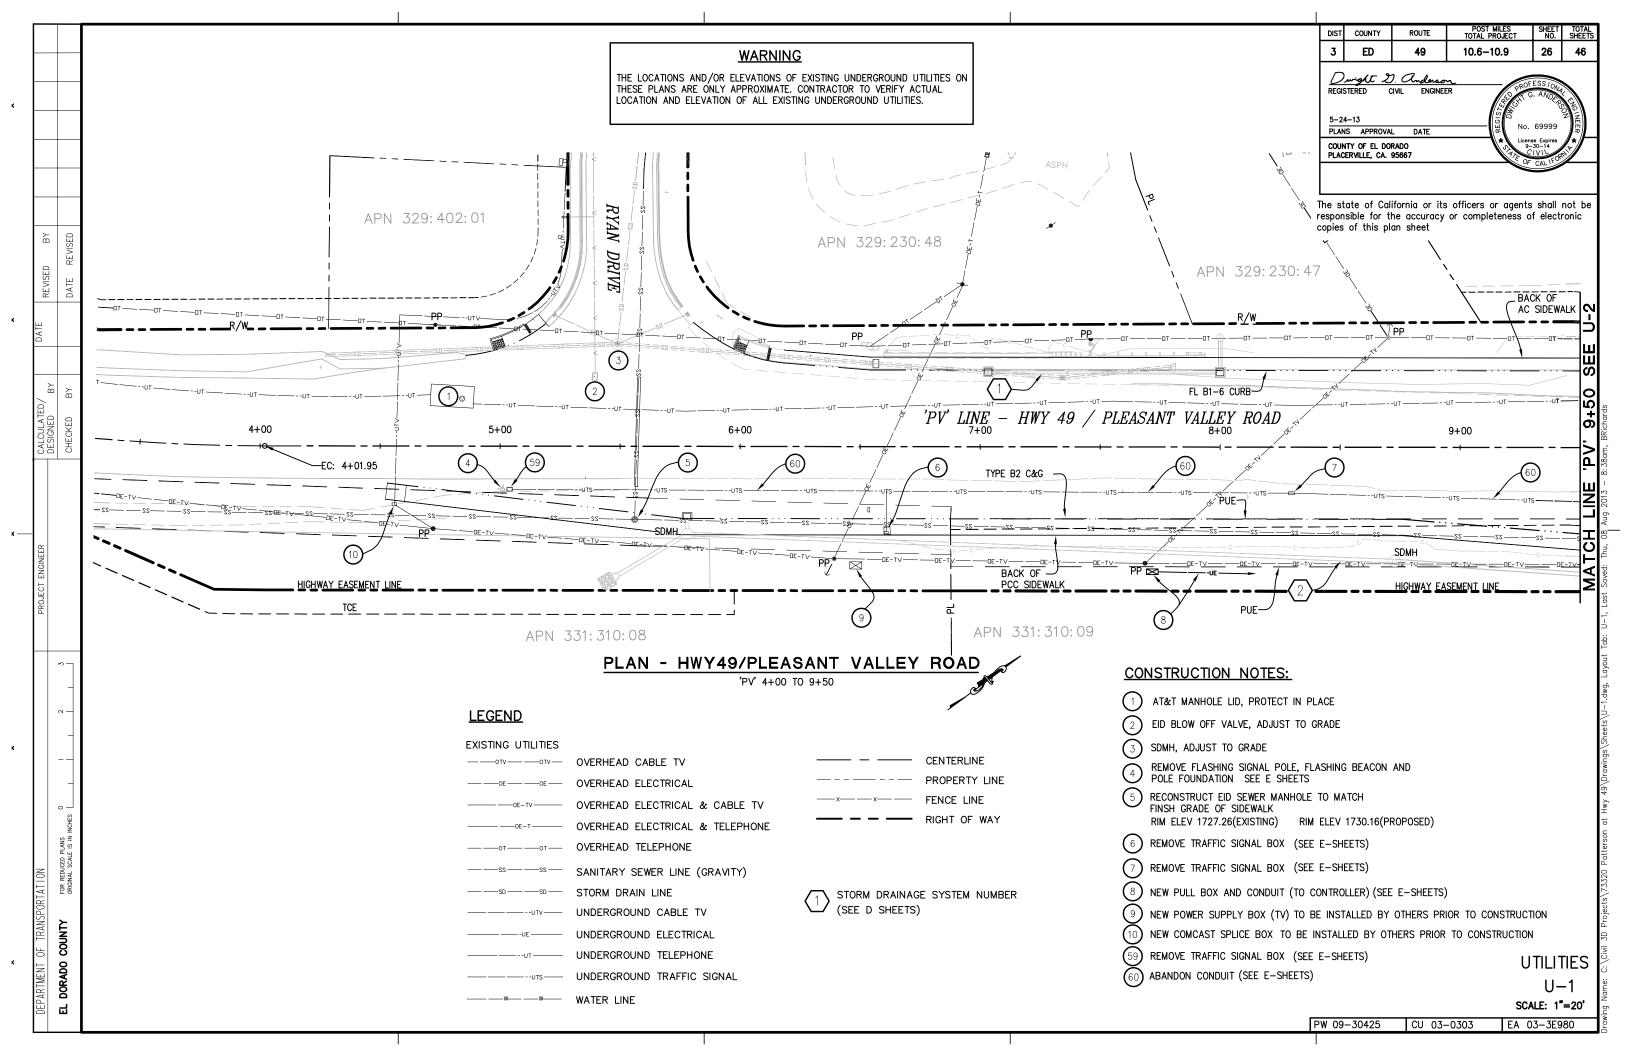


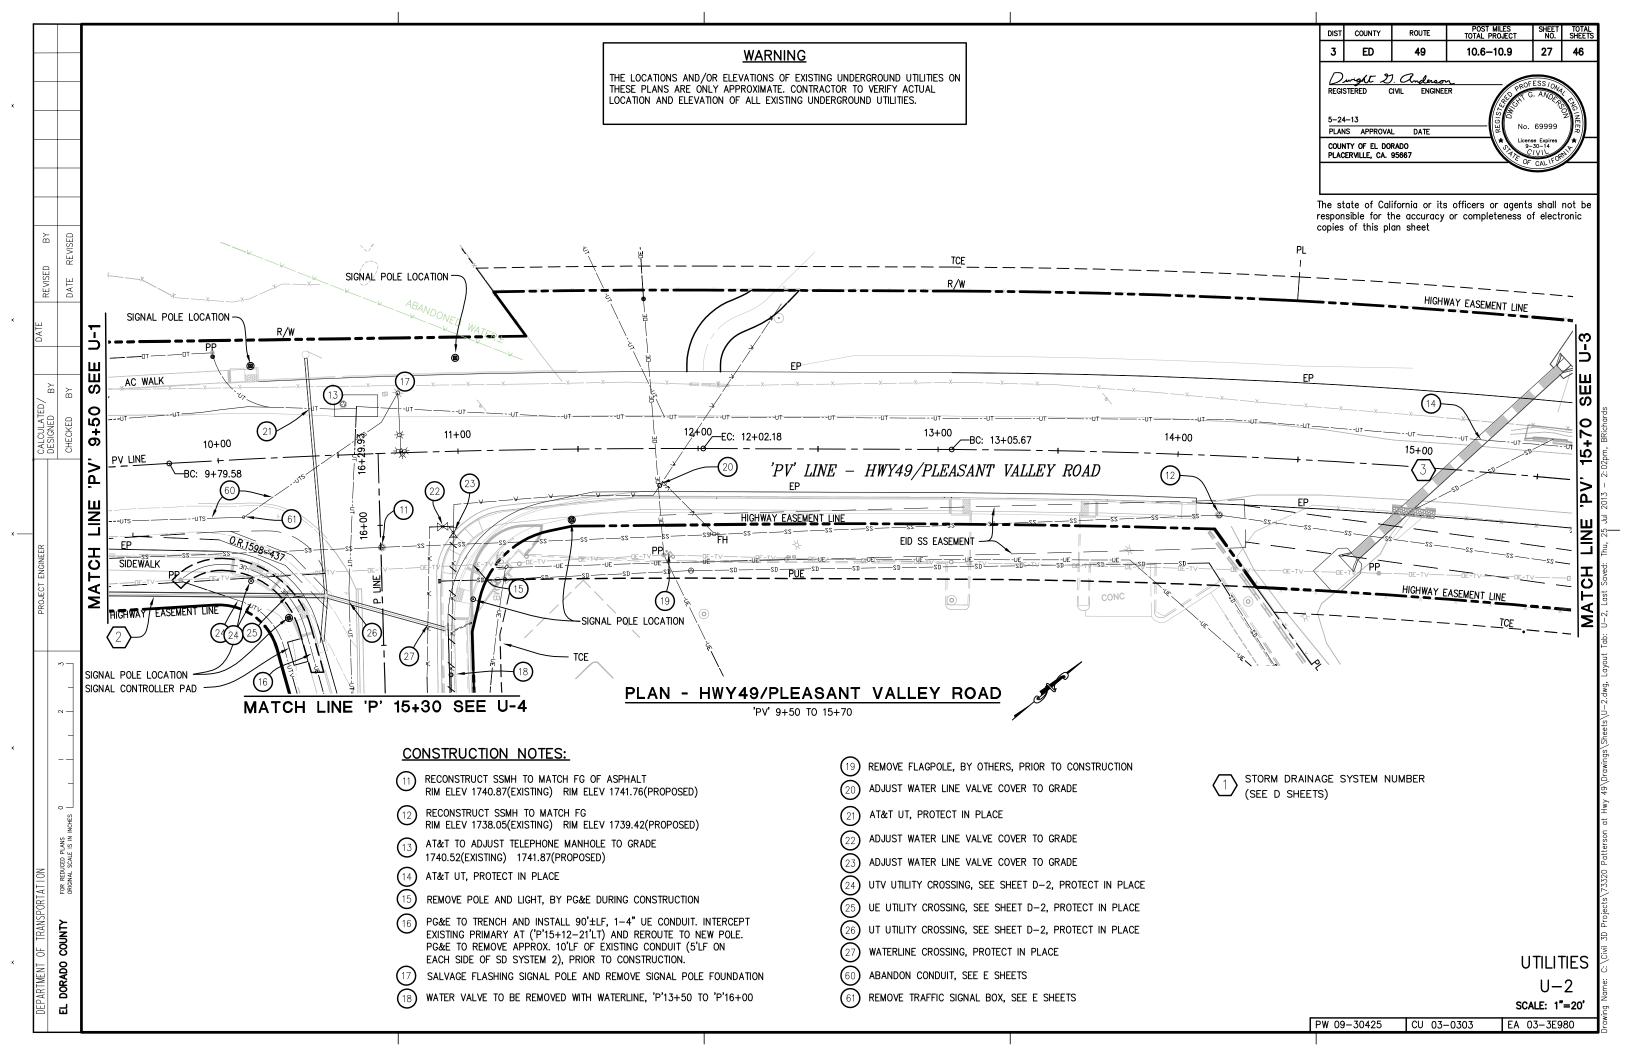



_			<u> </u>	007 IIII F0
				OST MILES SHEET TOTAL NO. SHEETS 6-10.9 28 46
			Durght D. Anderson REGISTERED CIVIL ENGINEER	
×			REGISTERED CIVIL ENGINEER	PROFESS ON A
		WARNING	5–24–13 PLANS APPROVAL DATE	— No. 69999 NEE
		WARNING  THE LOCATIONS AND/OR ELEVATIONS OF EXISTING UNDERGROUND UTILITIES ON	COUNTY OF EL DORADO PLACERVILLE, CA. 95667	License Expires \$\frac{\pi}{9-30-14}\$\frac{\pi}{20-16}\$\frac{\pi}{
F		THE LOCATIONS AND/OR ELEVATIONS OF EXISTING UNDERGROUND UTILITIES ON THESE PLANS ARE ONLY APPROXIMATE. CONTRACTOR TO VERIFY ACTUAL LOCATION AND ELEVATION OF ALL EXISTING UNDERGROUND UTILITIES.		OF CALL
F			The state of California or its officer responsible for the accuracy or con copies of this plan sheet	rs or agents shall not be
	BY ED		copies of this plan sheet	inpletelless of electronic
	REVIS			
	REVISED DATE	<u>TCE</u>		
,				
¥	DA			
		<b>O</b>		
	BY BY	O EP (29)		00
	NED NED (ED	PUE JTUTUTUTUTUTUTUT -		
1	CALCULATE DESIGNED CHECKED	<b>&gt;</b> 16+00	I ELACANIII WALLEY DOA	70.
		PV' LINE - HWY49/PA	LEASANT VALLEY KUAI	U
		EP		 
×		PP	Sp A	
	NEER	O = 52 = 55 = 55 = 55 = 55 = 55 = 55 = 5		_
	CT ENG	SSMH SSMH SSMH SSMH SSMH SSMH SSMH SSMH		. —
	PROJEC		SHADOWO	
			/ SHADOWS	:
	~ <u>_</u>	PLAN - HWY49/PLEASANT VALLEY ROAD		
		'PV' 15+70 TO 19+68  CONSTRUCTION NOTES:		
	7 —	AT&T TO ADJUST TELEPHONE MANHOLE TO GRADE 1738.71 (EXISTING) 1740.17 (PROPOSED)		
×		1740.17 (PROPOSÉD)  29 OVERHEAD GUY WIRE		
		30 GUY POLE AND ANCHOR		
	0 VCHES			
	JCED PLANS SCALE IS IN II			
3	FEDUCED			
1	OKIAI Por ORIG			
	KANSP			
,  F				וודוו ודובס
` India	RADO			UTILITIES   U-3
	DEPAKTIMENT OF TRANSPORTATION  EL DORADO COUNTY FOR REDU  ORIGINAL E			SCALE: 1"=20'
			PW 09-30425 CU 03-0303	EA 03-3E980

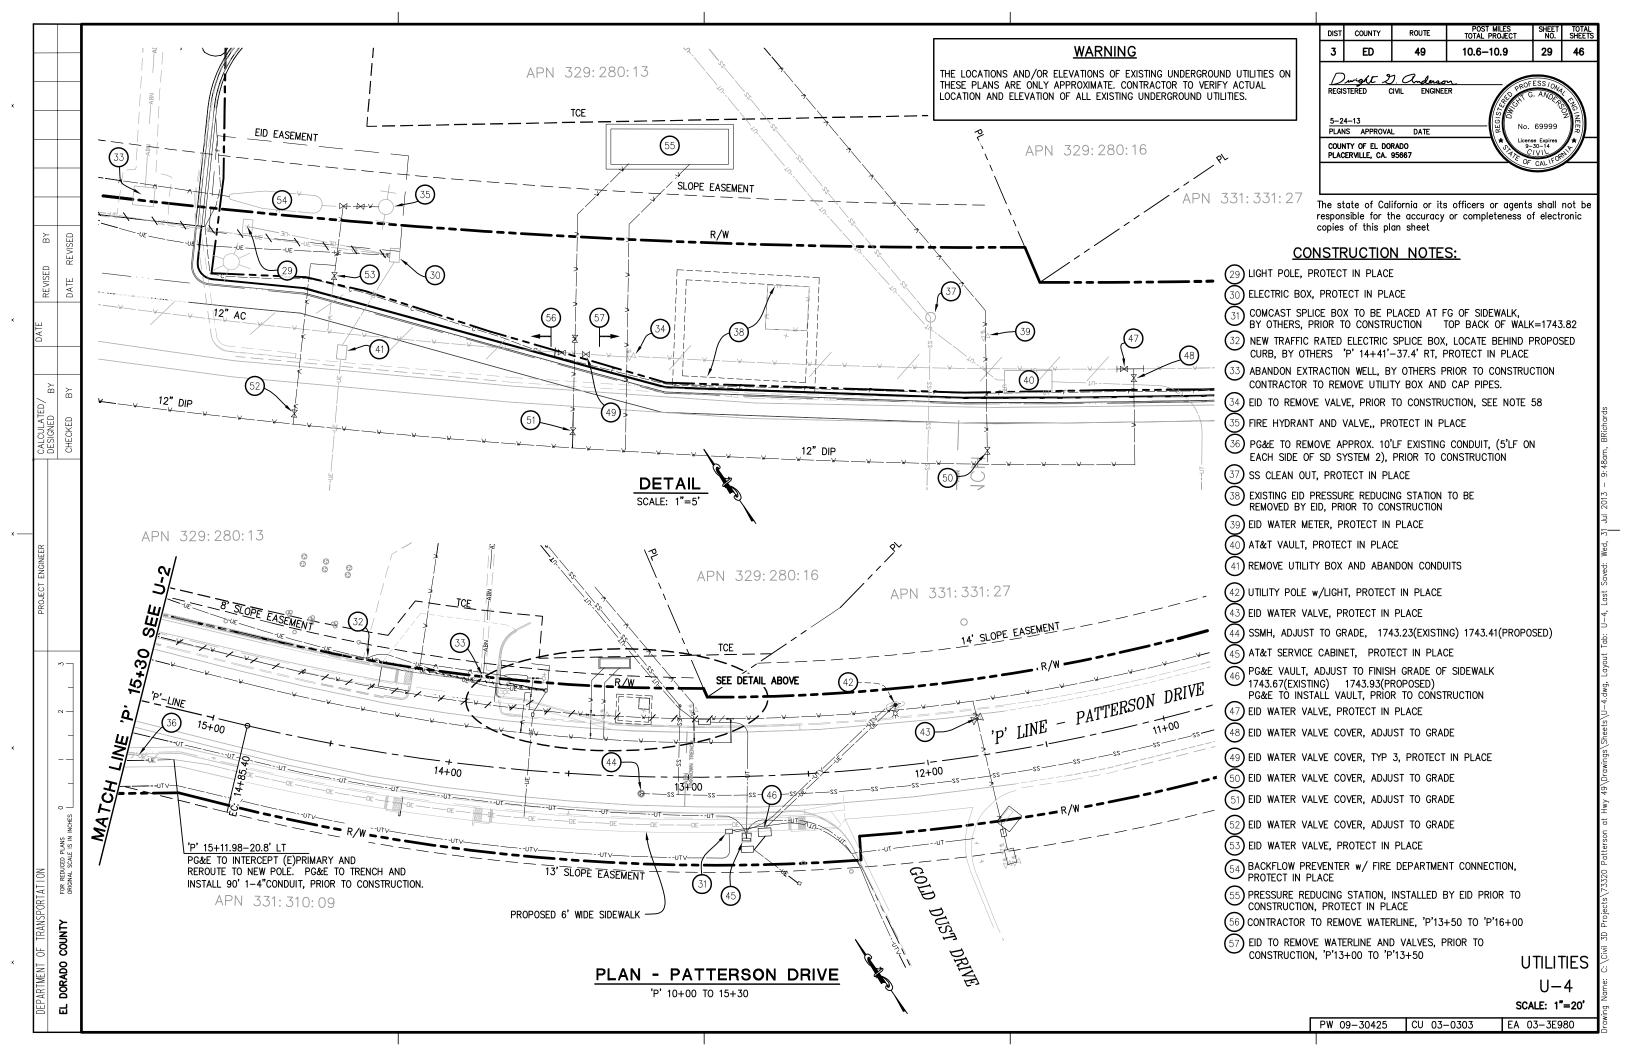

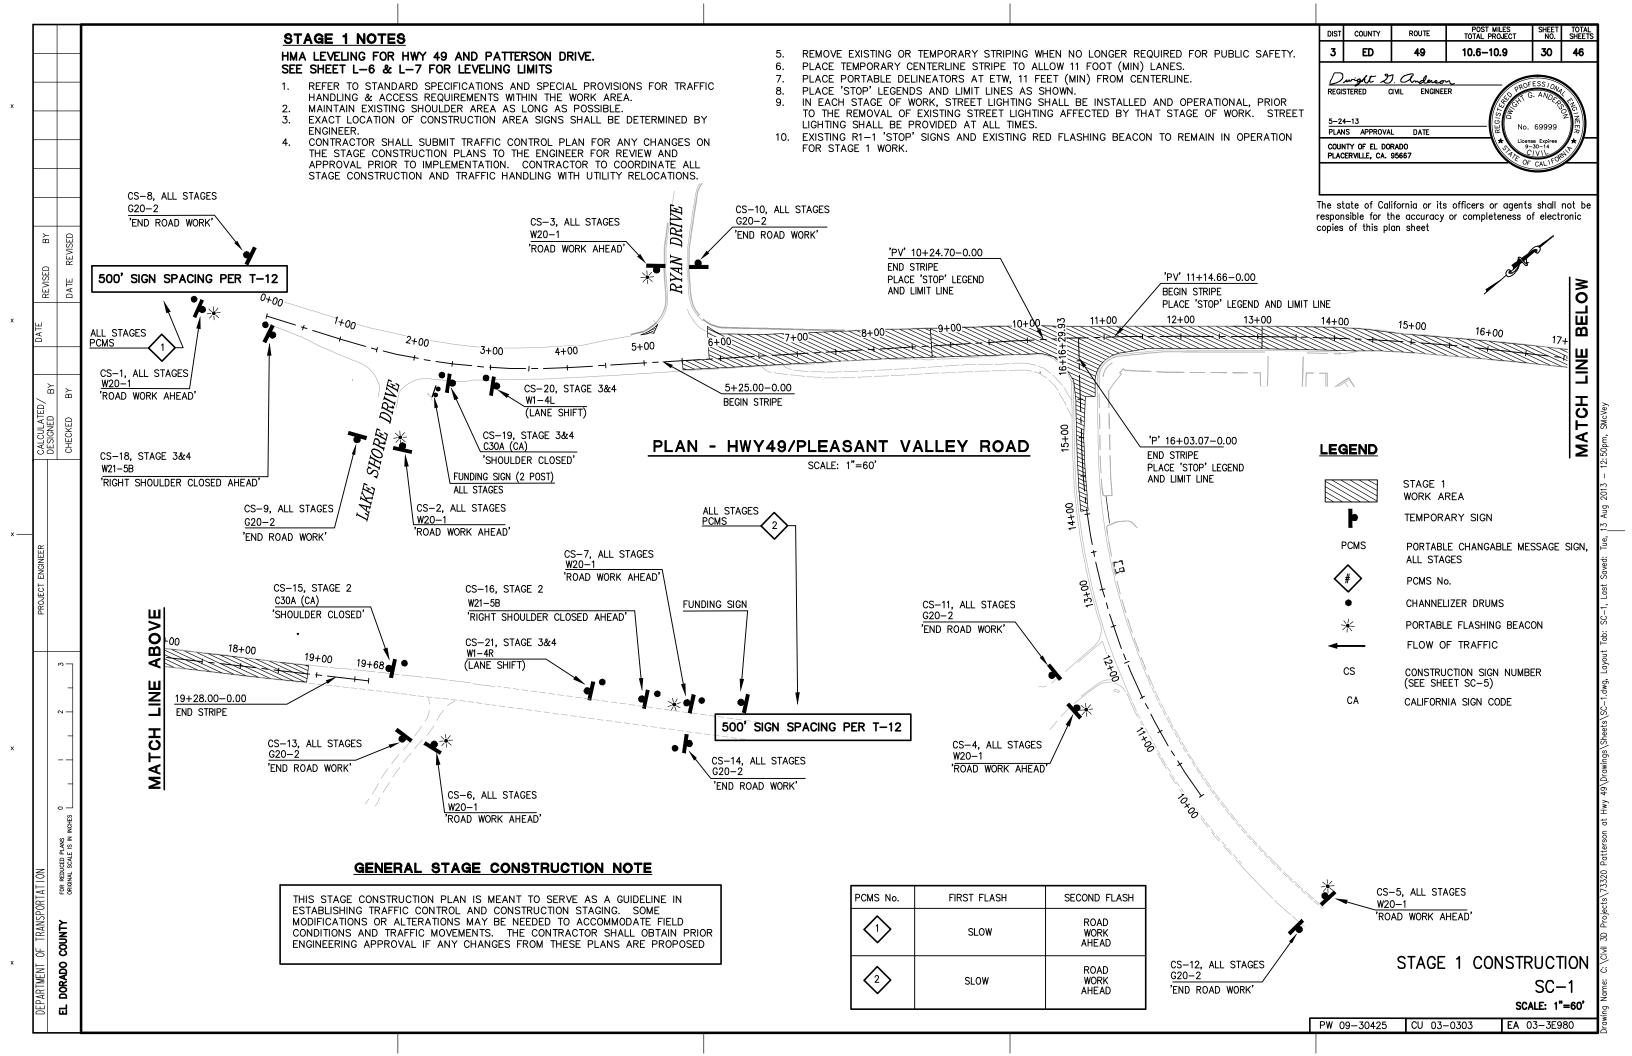

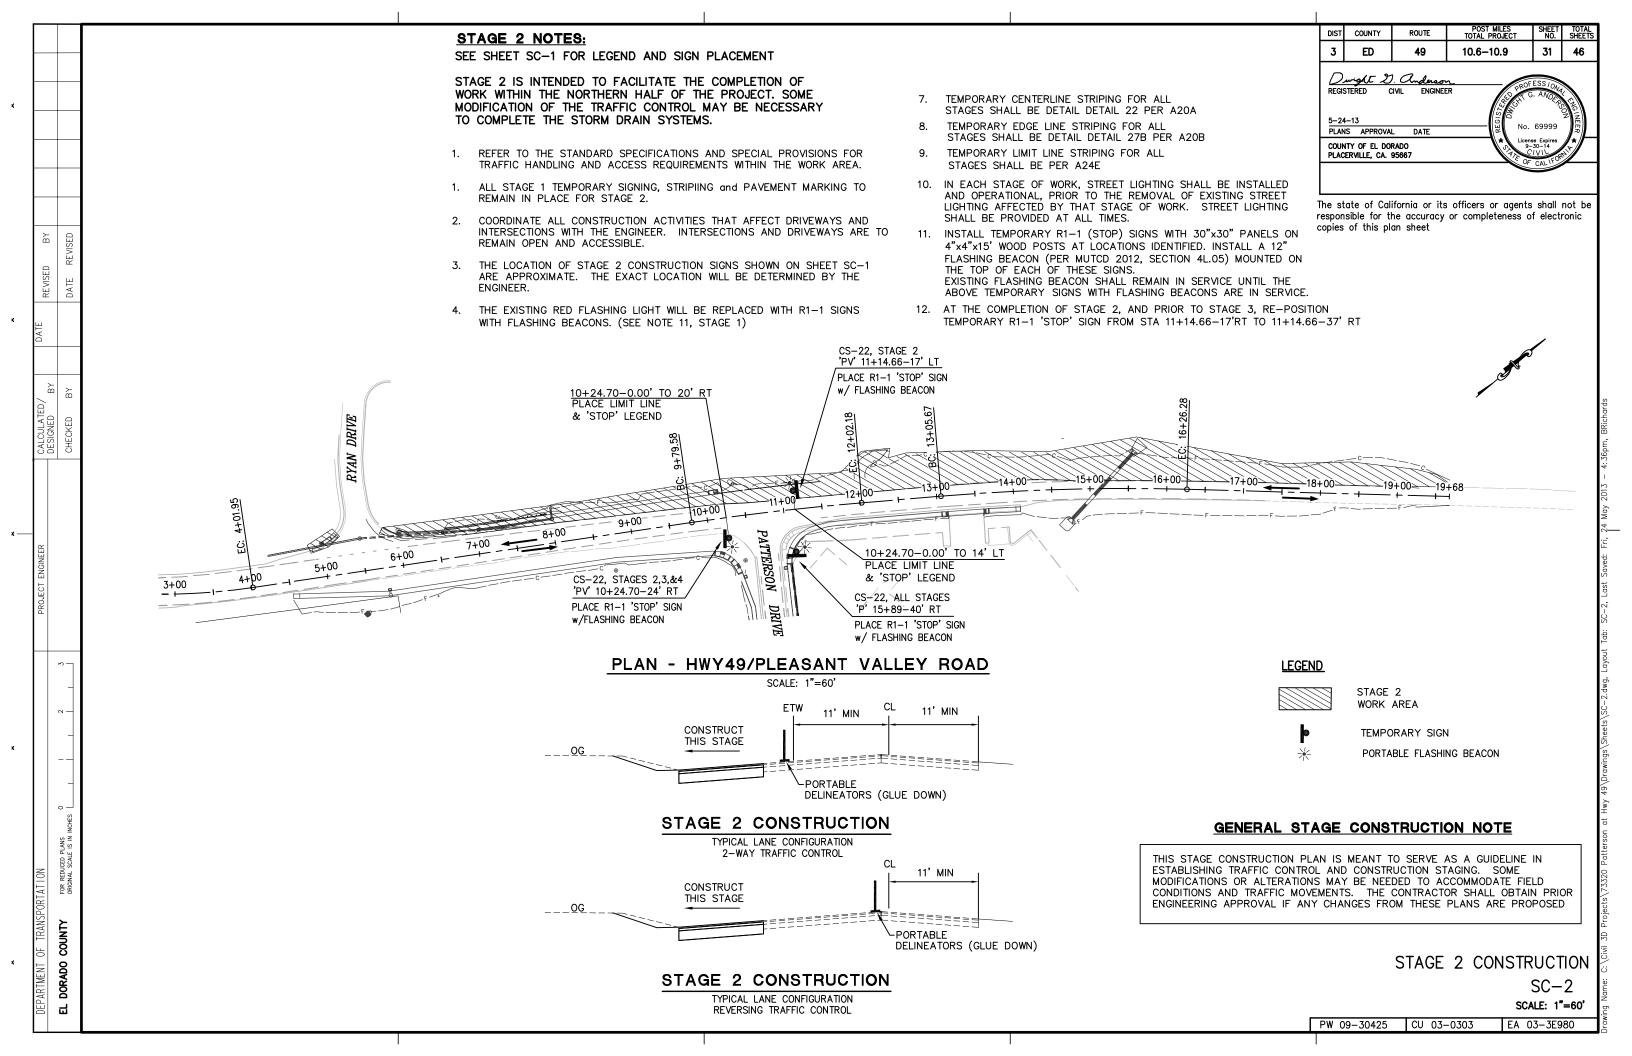

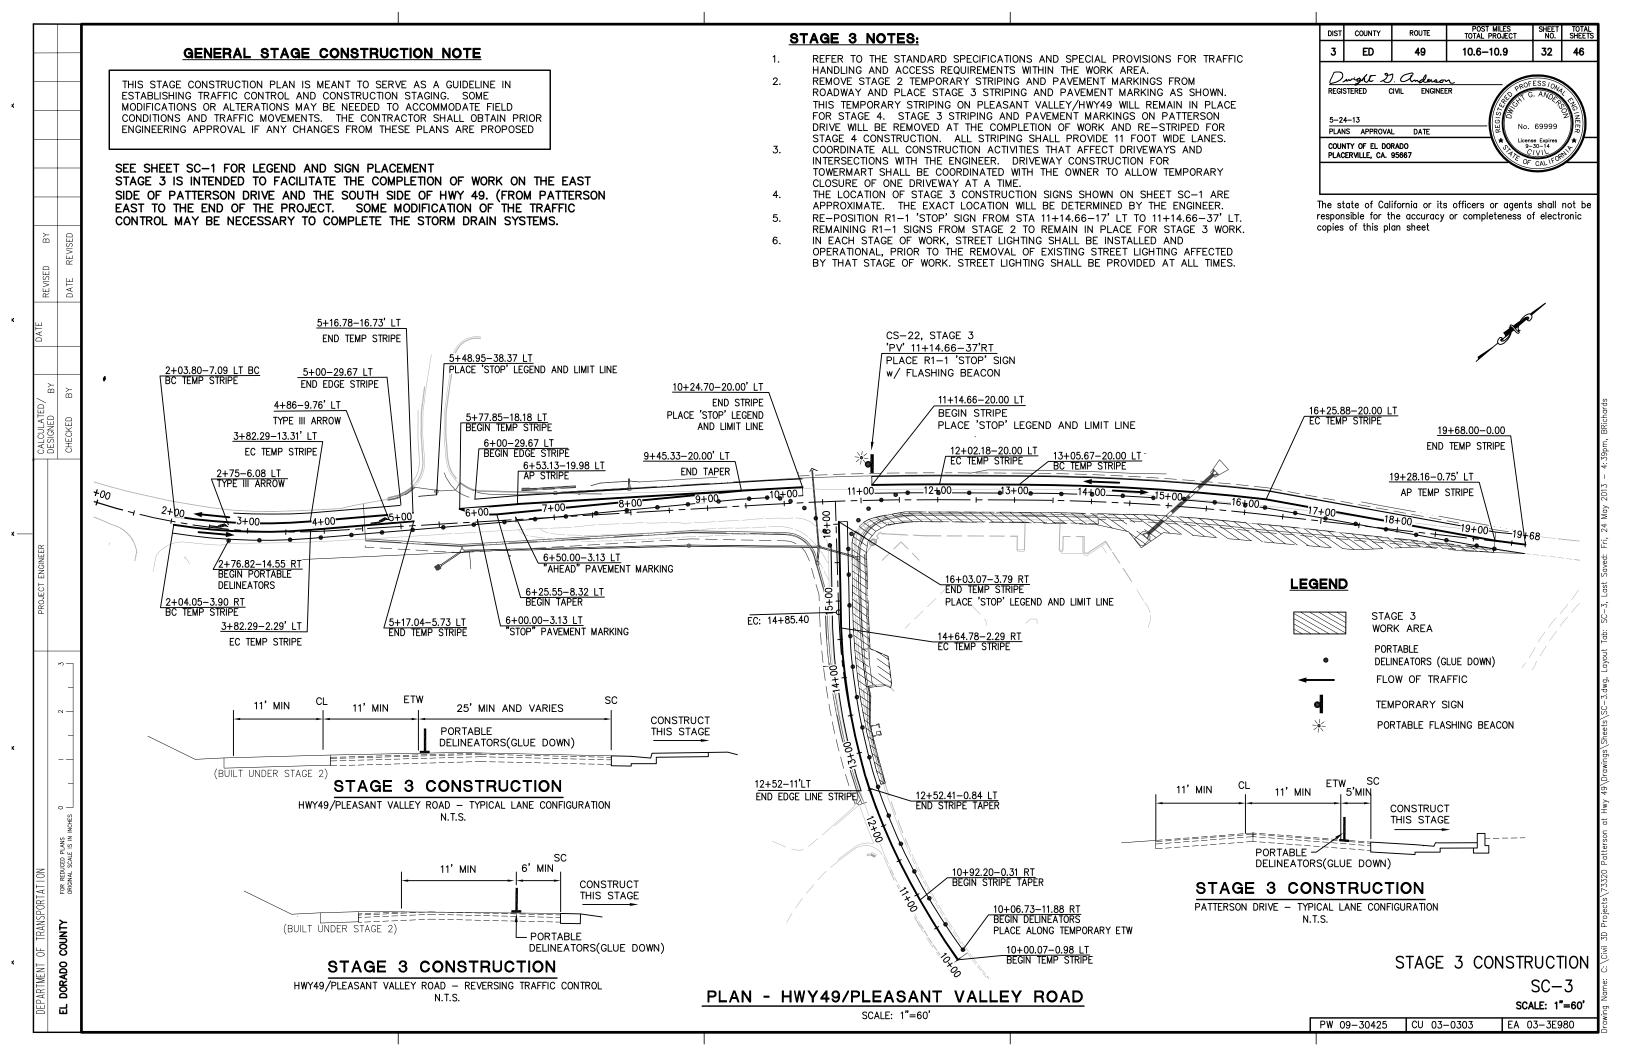

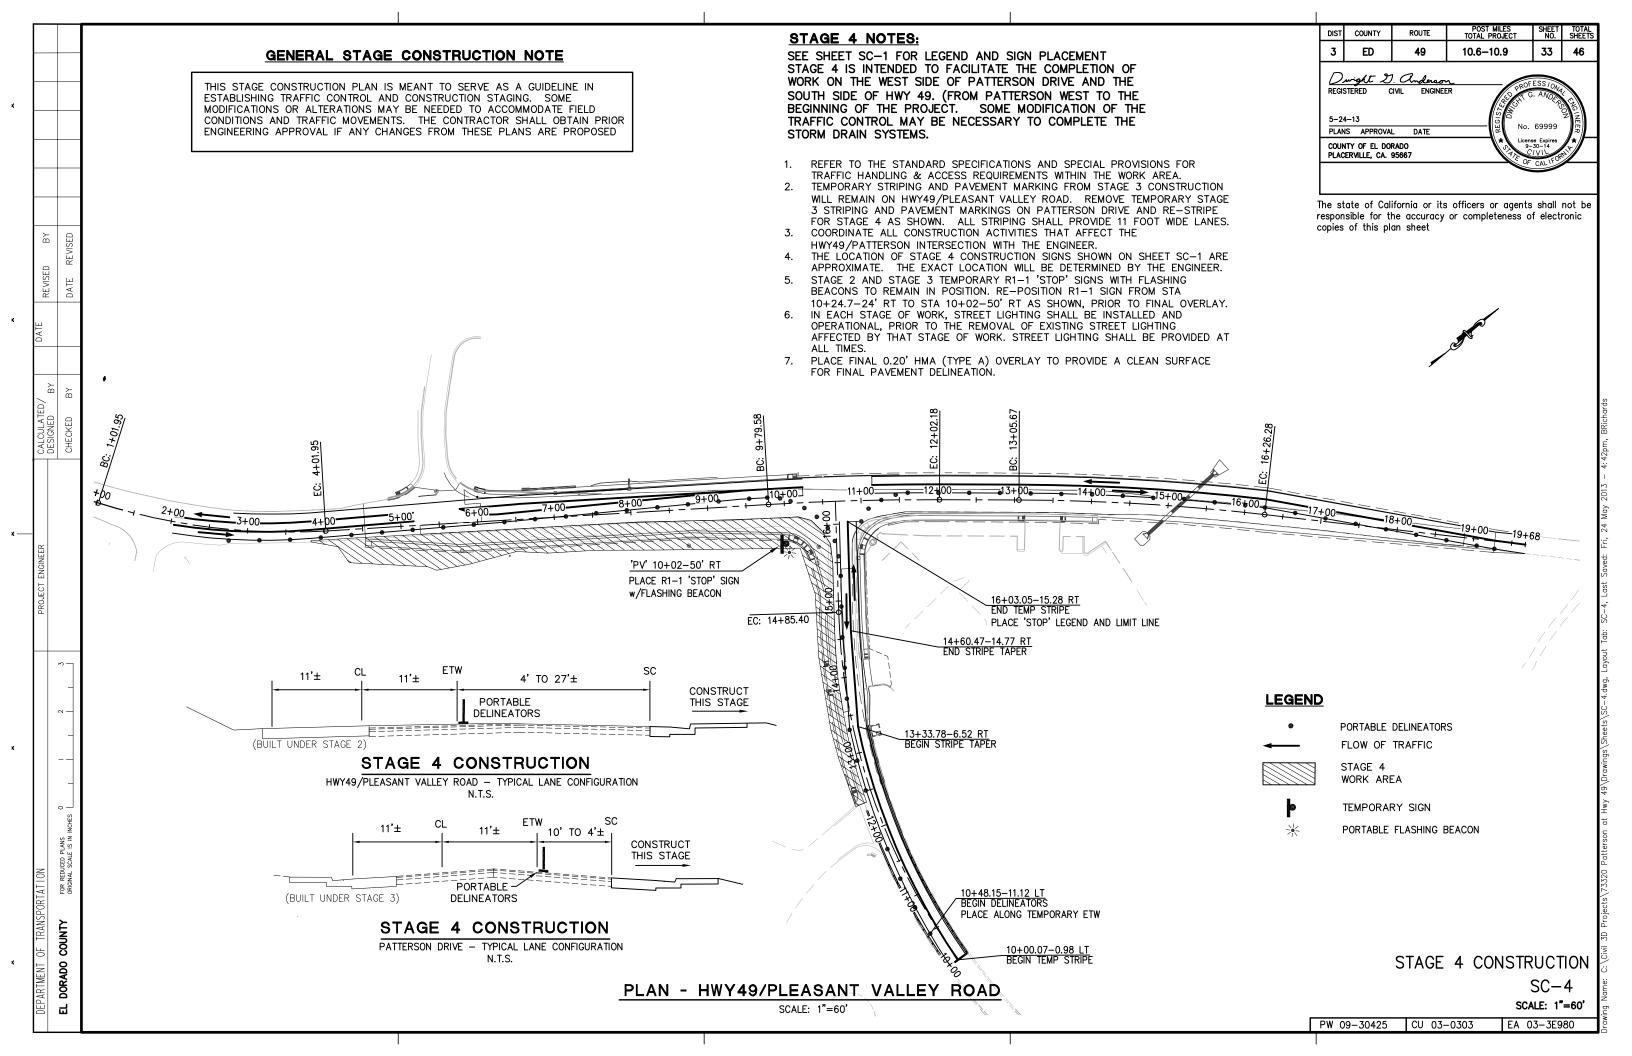

SIGN NO.	CONSTRUCTION STAGE	SIGN	CODE	PANEL SIZE INCHES	POST SIZE & LENGTH	INSTALI EA.
CS-1	ALL	ROAD WORK AHEAD	W20-1	48 × 48	6x6x12	1
CS-2	ALL	ROAD WORK AHEAD	W20-1	36 × 36	4x4x12	1
CS-3	ALL	ROAD WORK AHEAD	W20-1	36 × 36	4x4x12	1
CS-4	ALL	ROAD WORK AHEAD	W20-1	36 x 36	4×4×12	1
CS-5	ALL	ROAD WORK AHEAD	W20-1	36 × 36	4x4x12	1
CS-6	ALL	ROAD WORK AHEAD	W20-1	36 × 36	4x4x12	1
CS-7	ALL	ROAD WORK AHEAD	W20-1	48 × 48	6x6x12	1
CS-8	ALL	END ROAD WORK	G20-2	36 x 18	4x4x12	1
CS-9	ALL	END ROAD WORK	G20-2	36 x 18	4x4x12	1
CS-10	ALL	END ROAD WORK	G20-2	36 x 18	4x4x12	1
CS-11	ALL	END ROAD WORK	G20-2	36 x 18	4x4x12	1
CS-12	ALL	END ROAD WORK	G20-2	36 x 18	4x4x12	1
CS-13	ALL	END ROAD WORK	G20-2	36 x 18	4x4x12	1
CS-14	ALL	END ROAD WORK	G20-2	36 x 18	4x4x12	1
CS-15	2	SHOULDER CLOSED	C30A	48 x 48	6x6x12	1
CS-16	2	RIGHT SHOULDER CLOSED AHEAD	W21-5B	48 × 48	6x6x12	1
CS-18	3&4	RIGHT SHOULDER CLOSED AHEAD	W21-5B	36 × 36	4x4x12	1
CS-19	3&4	SHOULDER CLOSED	C30A	36 × 36	4x4x12	1
CS-20(CA)	3&4	LANE SHIFT	W1 – 4L	48 x 48	6x6x12	1
CS-21	3&4	LANE SHIFT	W1 – 4R	48 × 48	6x6x12	1
CS-22	ALL	'STOP' SIGN	R1-1	30 × 30	4x4x15	1

וכוט	COUNTY	ROUTE	TOTAL PROJECT	NO.	SHEETS
3	ED	49	10.6-10.9	34	46
		. Anderson		ESS ION	
KEG	STERED C	CIVIL ENGINEE		. ANDER	
5-2- PLAN	4-13 IS APPROVA	L DATE	REG!	69999	
COU	NTY OF EL DOI ERVILLE, CA.	RADO	9-	Se Expires 30-14 /VIL CAL IFOR	<i> </i> . -
				CALT	
ı					


The state of California or its officers or agents shall not be responsible for the accuracy or completeness of electronic copies of this plan sheet


TEMPORARY	STRIPING				
	L.F.				
STAGE 1	1606				
STAGE 2	1402				
STAGE 3	4497				
STAGE 4	1206				
TOTAL	8711				


DEPARTMENT OF TRANSF EL DORADO COUNTY

	TE	EMPORARY PAV "STOP" LEGEND, LIMI	VEMENT MARKING IT LINE & ARROWS				
		STA/OFFSET	(S.F.)				
STAGE 1		PV 10+24.70-0.00 PV 11+14.66-0.00 P 16+03.07-0.00	34 34 34				
STAGE	3	PV 5+48.95-38.37' LT PV 10+24.70-20.00' LT PV 11+14.66-20.00' LT P 16+03.07-3.79' RT PV 6+50.0-3.13 LT PV 6+00.00-8.32' LT PV 4+86-9.76' LT PV 2+75-6.08' LT	34 34 34 31 22 42 42				
STAGE 4		P 16+03.05-15.28' RT	34				
	TOTAL		409				

STAGE CONSTRUCTION SIGNS SC-5

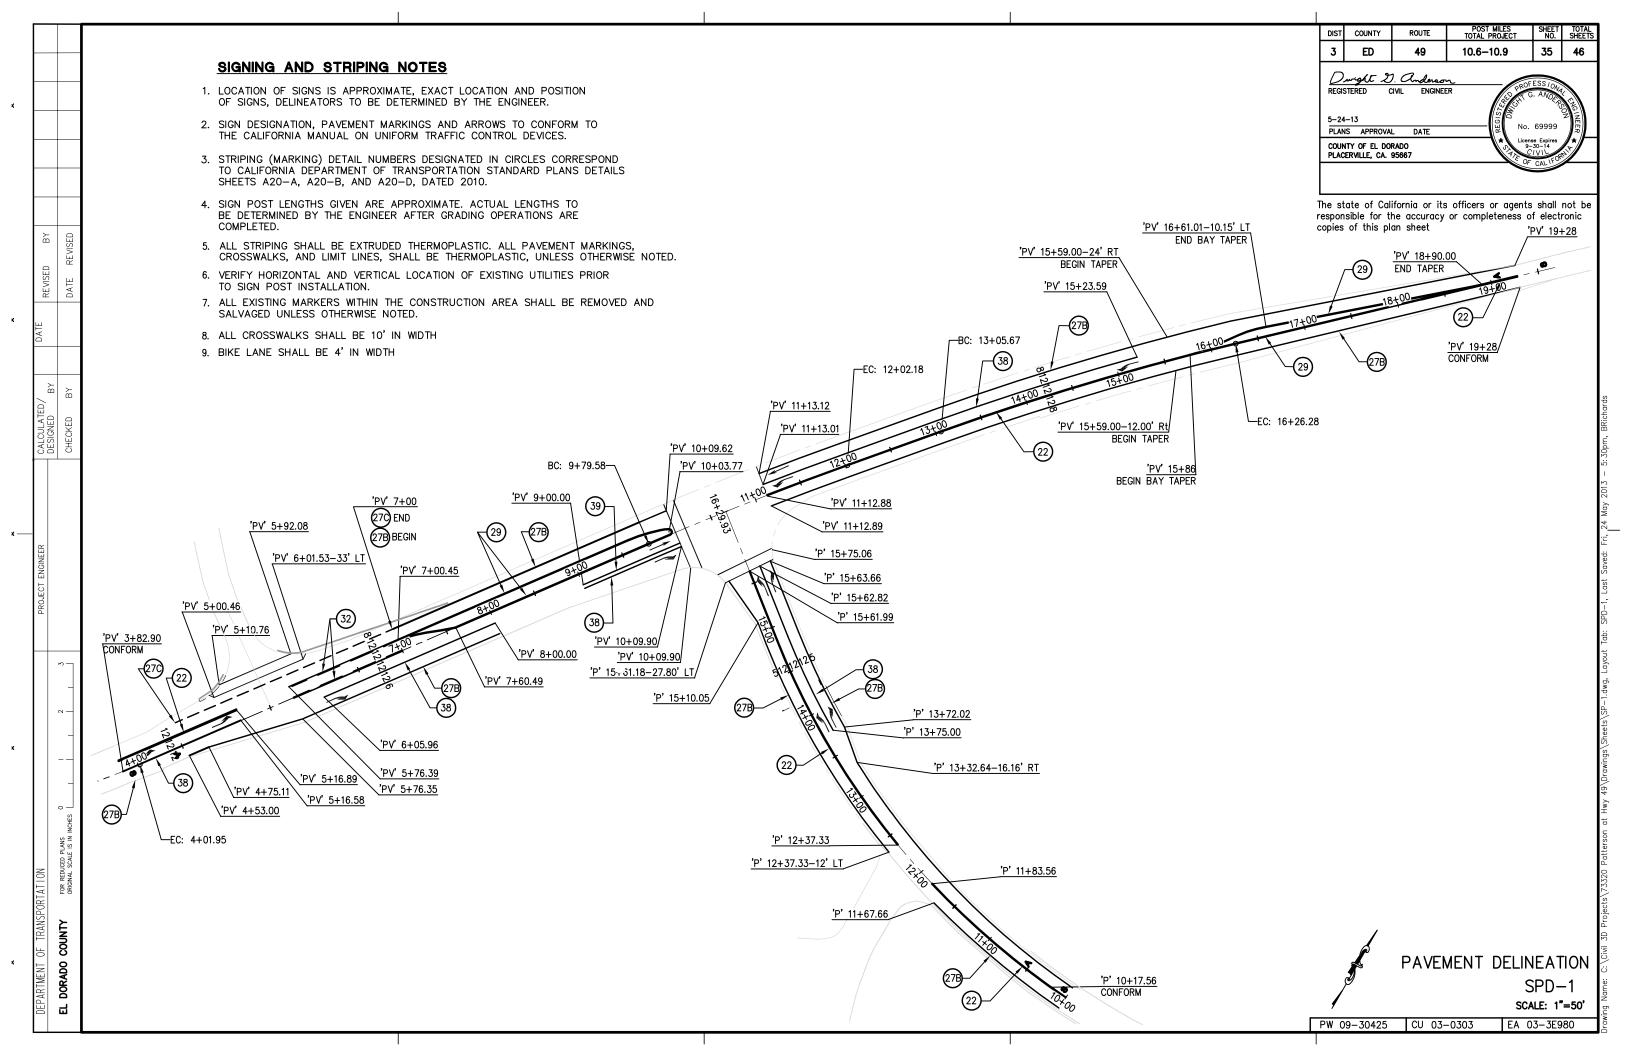

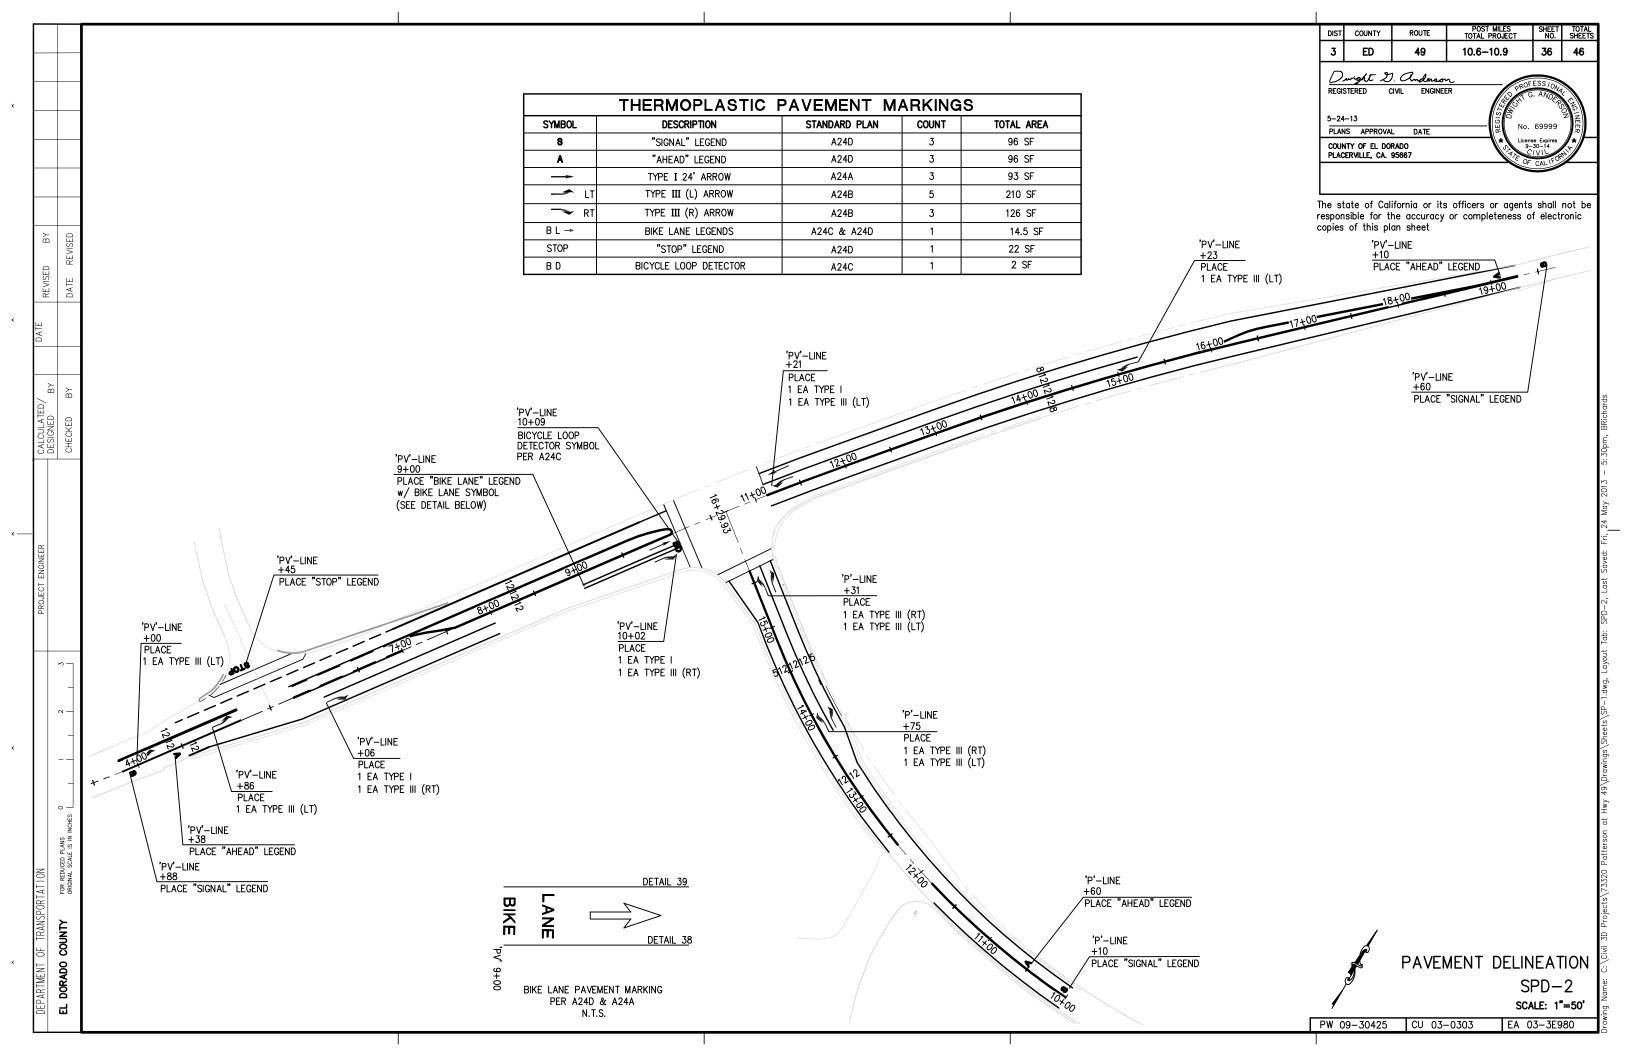

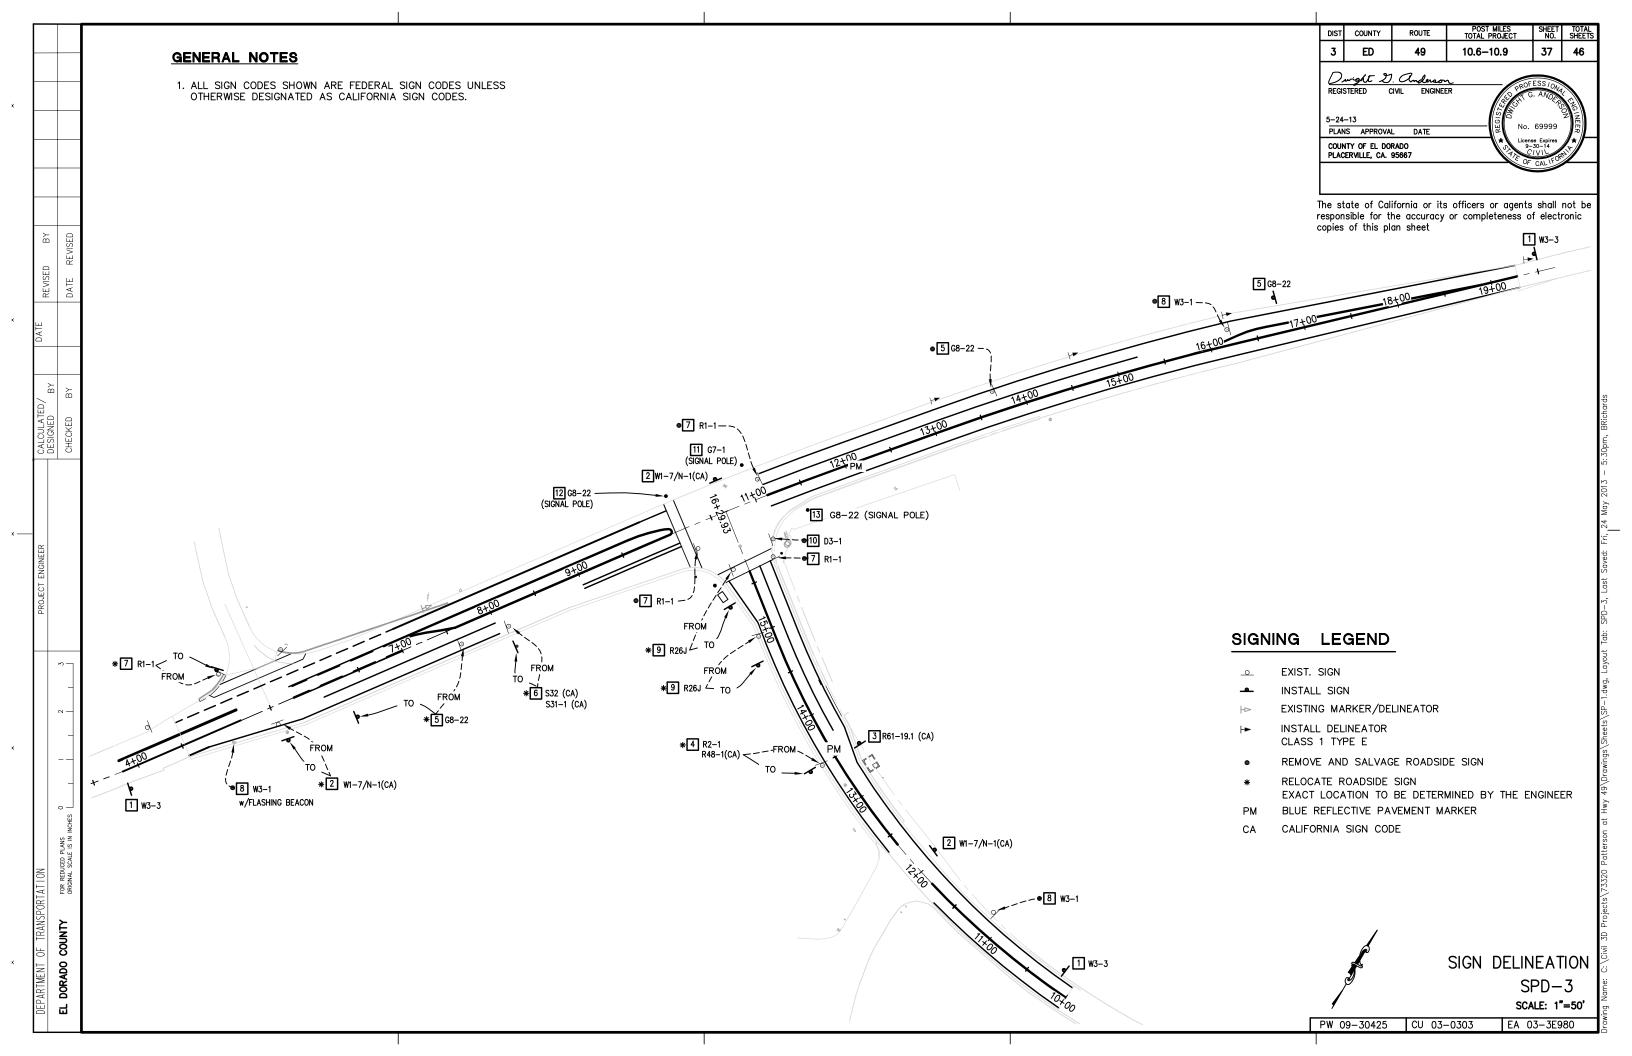

DIST COUNTY ROUTE TOTAL PROJECT NO. SHEETS

3 ED 49 10.6–10.9 38 46

Dight 20 Chalanan
REGISTERED CIVIL ENGINEER

5-24-13
PLANS APPROVAL DATE

COUNTY OF EL DORADO
PLACERVILLE, CA. 95667

The state of California or its officers or agents shall not be responsible for the accuracy or completeness of electronic copies of this plan sheet

	THERMOP	LASTIC	TRAFF	C STR	RIPE				
LOCATION	DETAIL	DESCRIP'	TION	12" WIDE		6" WIDE		WIDE	REFLECTIVE
LOCATION	NO.			WHITE FT	WHITE	WHITE	WHITE	YELLOW	MARKERS TYPE/QNT.
					FT	FT	FT	FT	TIPE/QIVI.
'P' 10+00 - 11+83.56	21 - A20A		NO PASSING					366	
'PV' 4+53.00 - 5+16.89		2 DIR	2 DIRECTION					128	
'PV' 11+12.88 - 15+77.40								930	
'PV' 18+90 - 19+28	22 - A20A		ASSING ECTION					76	D - 75
'PV' 4+53.00 - 5+16.89		2 0110	LOTION					128 650	
'P' 12+37.33 - 15+62								630	
14							754		
'PV' 4+53.00 — 8+00 R							351 310		
'PV' 7+00 - 10+09.62 L							815		
'PV' 11+13.12 - 19+28 L	27B - A20B	EDGE	LINE				815		
'PV' 11+12.89 - 19+28 R							564		
'P' 10+00 - 15+63.66 R									
'P' 10+00 - 11+67.66 L							167 327		
'P' 12+37.33 - 15+59.92 L 'PV' 4+50.00 - 7+00.00 L	27C - A20B	DACUE	DOE LINE				250		
	27C - A20B	DASH E	DGE LINE				200		
'P' 13+75 - 15+62.82					188				
'PV' 4+53.00 - 5+16.58 'PV' 6+05.96 - 10+09.90					64				G - 49
'PV' 11+13.01 - 15+23.59	38 - A20D	CHANN	ELIZING		404 411				
'PV' 9+00 - 10+09.90					109				
'PV' 5+76.39 - 7+60.49	32 - A20B	TWO WAY	TURN LANE		100			736	D - 39
'PV' 7+00.45 - 10+09.90								4070	
'PV' 15+77.40 - 18+90	29 - A20B	MEDIAN	ISLANDS					1238	D - 104
								1250	
'PV' 5+10 - 5+92 L	RSP - A24F	BASIC C	ROSSWALKS	198					
'PV' 10+09.90 R - 10+09.62 L 'P' 15+59.92 L - 15+63.66 R	RSP - A24F	DASIC CI	(OSSWALKS	149 119					
'PV' 11+12.88	A24E	LIMI	T LINE	33					
'PV' 9+00 - 10+09.90	39 — A20D	BIKE L	ANE LINE			109			
			TOTAL	499	1176	109	3349	5502	

PAVEMENT DELINEATION QUANTITIES SPD-4

SCALE: 1"=50'

×	x	x		×
DEPARTMENT OF TRANSPORTATION		PROJECT ENGINEER	\   	DATE
			DESIGNED BY	
EL DORADO COUNTY FOR REDUCED PLANS 0 ORIGINAL SCALE IS IN INCHES 1	2 3		CHECKED BY	

DIST	COUNTY	ROUTE	POST MILES TOTAL PROJECT	SHEET NO.	TOTAL SHEETS
3	ED	49	10.6-10.9	39	46
5-24 PLAI	STERED (	RADO	No.	69999 se Expires 30–14 /VIL CAL IFOR	EXIG INEER

The state of California or its officers or agents shall not be responsible for the accuracy or completeness of electronic copies of this plan sheet

CLASS 1 TYPE E DELINEATORS	STATION	QNT.
<b>⊢</b> ►E	PV 13+06 LT	1
	PV 14+66 LT	1
	PV 16+26 LT	1
	PV 19+46 LT	1
	TOTAL	4

CALCULATED/ DESIGNED BY


DEPARTMENT OF TRANSP EL DORADO COUNTY


BLUE REFLECTIVE PAVEMENT MARKERS	STATION	QNT.
РМ	'PV' 12+02-0.7' RT	1
РМ	'P' 13+67-0.7' RT	1
	TOTAL	2

					SIG	N QUA	NTITI	ES				
				POST	SI7F		ROADSIDE	SIGNS			PROPOSED	REMARKS
SIGN NO.	SIGN	CALIFORNIA MUTCD CODE	PANEL SIZE (INCHES)	& LE	NGTH	INSTALL (STRAP &	ONE POST	RELOCATE	REMOVE	EXISTING LOCATION	LOCATION (APPROXIMATELY)	
1	SIGNAL AHEAD SYMBOL	W3-3	48 X 48	4" X 4"	4" X 6" 16 16 16	SADDLE) EA	1 1 1	EA	EA		'PV' 3+90 RT 'PV' 19+60 LT 'P' 10+15 RT	
2	TWO DIRECTION - LARGE ARROW	W1-7 N-1(CA)	48 X 24 18 X 18		15		1 1	1		'PV' 5+50-19 RT	'PV' 5+54-38' RT 'PV' 10+65 LT 'P' 12+20 RT	
3	INTERSECTION LANE CONTROL	R61-19.1(CA)	30 X 24	15			1				'P' 13+50 RT	
4	SPEED ADVISORY	R2-1 R48-1 (CA)	30 X 24		15			1		'P' 13+50-16' LT	'P' 13+50-30' LT	
5	STREET NAME	G8-22 (CA)	54 X 30					1		'PV' 7+60-18.5' RT 'PV' 13+70-21.8' LT	'PV' 6+75-40.2' RT	PATTERSON DRIVE
					15		1				'PV' 16+75-31' LT	PATTERSON DRIVE
6	ADOPT A HWY	S32 (CA)						1		'PV' 8+11-20.7' RT	'PV' 8+11-43' RT	
7	'STOP'	R1–1						1	1 1 1	'PV' 8+11-20.7' LT 'PV' 10+24-24.4' RT 'PV' 10+95-61.5' RT 'PV' 11+10-18.8' LT	'PV' 8+11-43' LT	
8	'STOP AHEAD'	W3-1							1 1 1	'P' 11+15-23' RT 'PV' 16+20-16' LT 'PV' 5+01-17' RT		
9	'NO PARKING'	R26J						1		'P' 15+72-15' LT	'P' 15+35-38' LT	
								1		'P' 14+96-16' LT	'P' 14+70-28' LT	
10	STREET NAME	D3-1							1	'PV' 11+02-44.4' RT		
11	STREET NAME	G7-1	54 X 30									PLEASANT VALLEY ROAD INSTALL ON SIGNAL STANDARD
12	STREET NAME	G8-22	54 X 30									PATTERSON DRIVE INSTALL ON SIGNAL STANDARD
13	STREET NAME	G8-22	54 X 30									PATTERSON DRIVE ————————————————————————————————————
				•	TOTAL		7	7	8		•	

SIGN QUANTITIES SPD-5

SCALE: 1"=50'

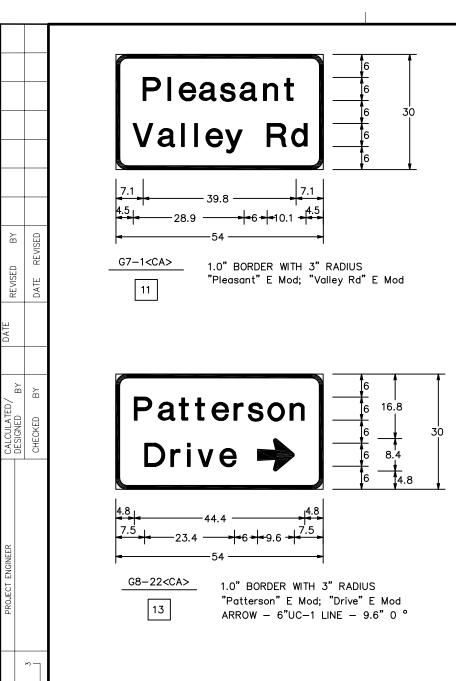

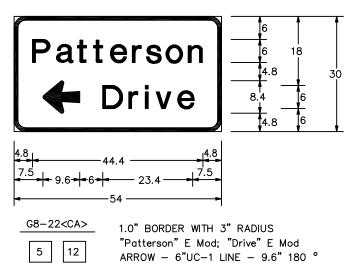

COUNTY

딥

DIST	COUNTY	ROUTE	POST MILES TOTAL PROJECT	SHEET NO.	TOTAL SHEETS
3	ED	49	10.6–10.9	40	46

Duright D. anderson REGISTERED CIVIL ENGINEER 5-24-13 PLANS APPROVAL DATE

COUNTY OF EL DORADO PLACERVILLE, CA. 95667

The state of California or its officers or agents shall not be responsible for the accuracy or completeness of electronic copies of this plan sheet

#### ROADSIDE SIGN PANEL QUANTITIES

				S	BACKGRO	UND	LEGEN	D	PROTECTIVE- FILM OVERLAY	FURI SINGLE		
				SIGNS		TIVE		JIIVE		ALUMINU		
SIGN CODE	SIGN MESSAGE/DESCRIPTION	SIGN SIZE	SIGN	P				낊퓦		UNF	RAMED	REMARKS
		L×D	AREA	NUMBER	SHEETING COLOR	RETROREFLECTIVE ASTM TYPE	SHEETING COLOR	RETROREFLECTIVE ASTM TYPE	PREMIUM	0.063"	0.080"	
		(INCHES)	(SQFT)			뮖		RE		SQFT	SQFT	
R3-4	NO U-TURN (Symbol)	36 x 36	9.00	2	WHITE	Ш	BLACK RED	III	x	18.00		
R9-3a	NO PEDESTRIANS (Symbol)	24 x 24	4.00	2	WHITE	Ш	BLACK RED	III	×	8.00		
R9-3bR	USE CROSSWALK w/ RIGHT ARROW	24 x 16	2.67	1	WHITE	Ш	BLACK		Х	2.67		
R9-3bL	USE CROSSWALK w/ LEFT ARROW	24 x 16	2.67	1	WHITE	Ш	BLACK		X	2.67		
R61-19.1(CA)	INTERSECTION LANE CONTROL	30 x 24	5.00	1	WHITE	Ш	BLACK		X	5.00		
R73-3(CA)	INTERSECTION LANE CONTROL	36 x 36	9.00	2	WHITE	Ш	BLACK		X	18.00		
W1-7	TWO-DIRECTIONAL ARROW (Symbol)	48 x 24	8.00	2	YELLOW	IX	BLACK		X		16.00	
W3-3	SIGNAL AHEAD (Symbol)	48 × 48	16.00	3	YELLOW	l IX	BLACK		×		48.00	
	` , ,						RED, GREEN	IX			10.00	
N-1(CA)	YELLOW OBJECT MARKER	18 x 18	2.25	2	YELLOW	III			Х	4.50		
G7-1(CA)	Pleasant Valley Rd	54 x 30	11.25	1	GREEN	IV	WHITE	ΙX	х		11.25	SIGN 12
G8-22(CA)	Patterson Drive →	54 x 30	11.25	1	GREEN	IV	WHITE	ıx	x		11.25	SIGN 14
G8-22(CA)	Patterson <b>←</b> Drive	54 x 30	11.25	2	GREEN	IV	WHITE	IX	х		22.50	SIGNS 5 AND 13
		•	•				TO <sup>-</sup>	ΓAL		58.84	109.00	

L = LENGTH OF SIGN D = DEPTH OF SIGN


SIGN DETAILS AND QUANTITIES


PW 09-30425 CU 03-0303

SPD-6

NOTE: ALL SIGN PANEL DIMENSIONS ARE IN INCHES.

EA 03-3E980

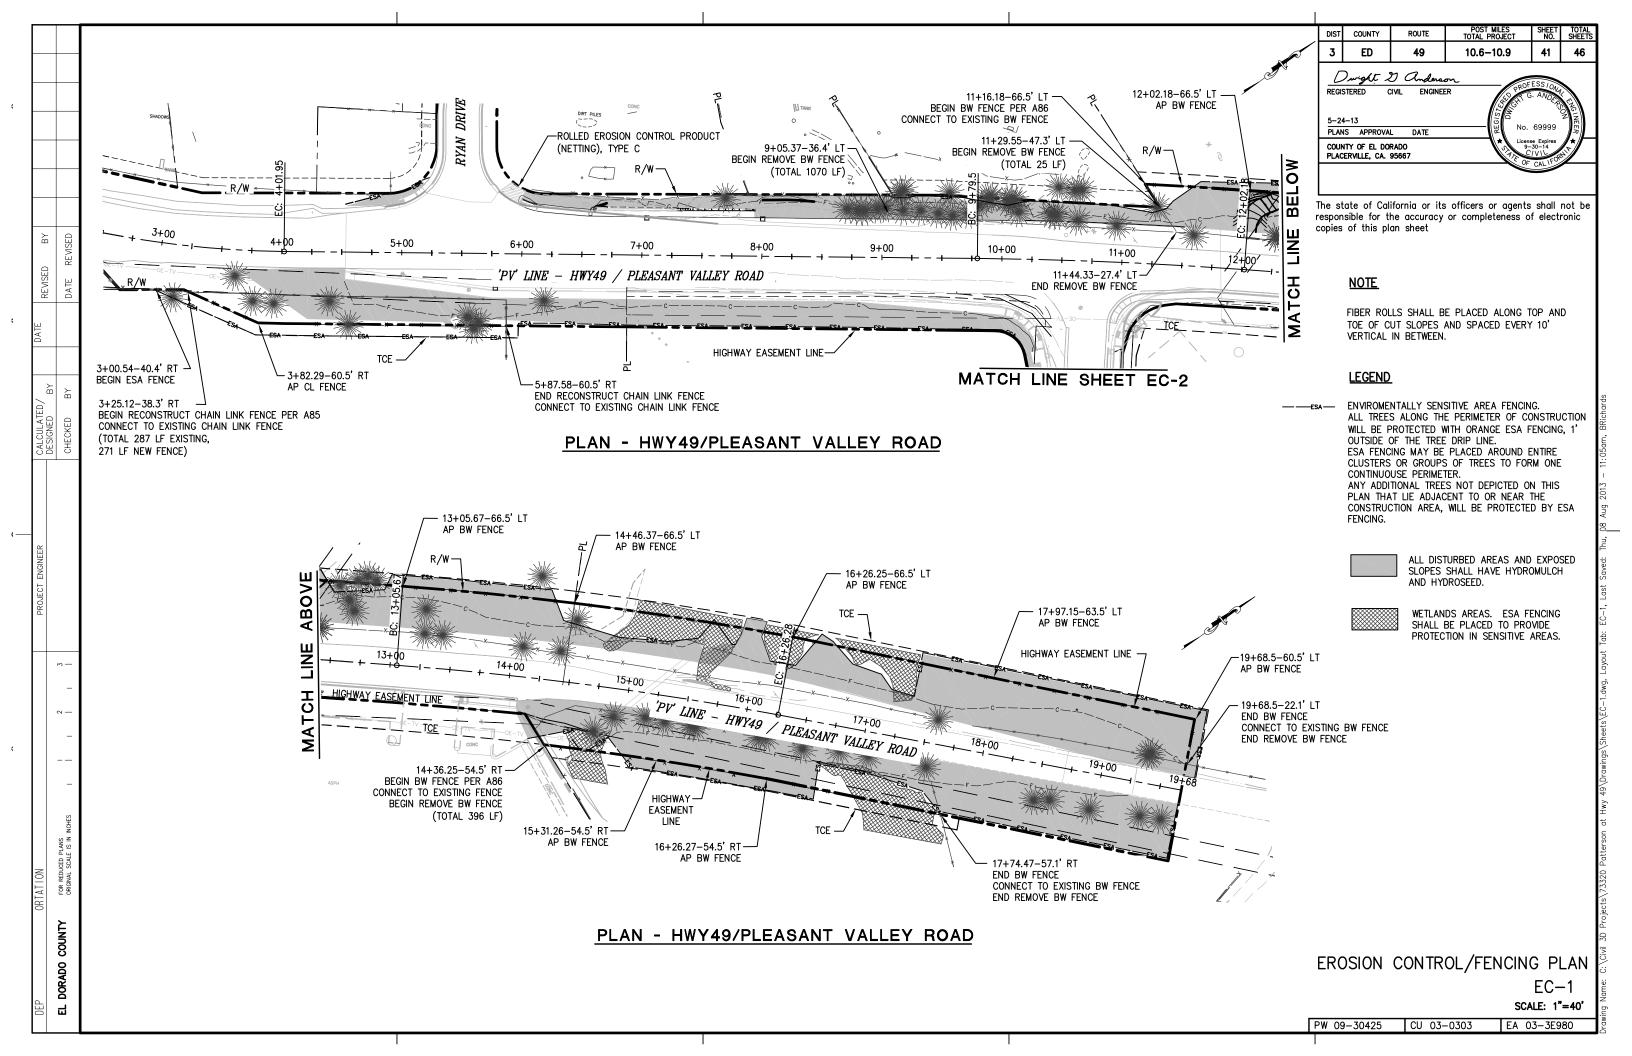

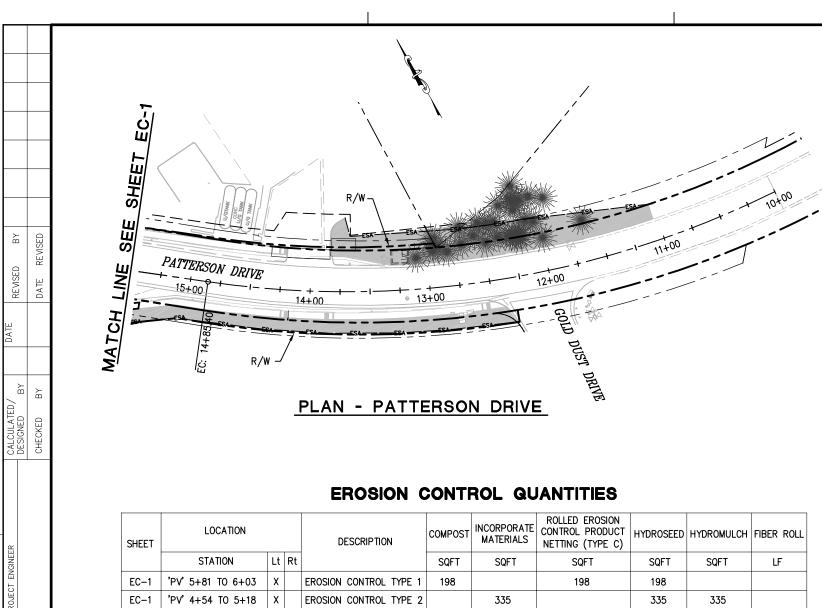

SHEET	LOCATION			DESCRIPTION	COMPOST	INCORPORATE MATERIALS	ROLLED EROSION CONTROL PRODUCT NETTING (TYPE C)	HYDROSEED	HYDROMULCH	FIBER ROLL
	STATION	Lt	Rt		SQFT	SQFT	SQFT	SQFT	SQFT	LF
EC-1	'PV' 5+81 TO 6+03	Х		EROSION CONTROL TYPE 1	198		198	198		
EC-1	'PV' 4+54 TO 5+18	Х		EROSION CONTROL TYPE 2		335		335	335	
EC-1	'PV' 6+00 TO 19+77	Х		EROSION CONTROL TYPE 2		36,740		36,740	36,740	
EC-1	'PV' 3+65 TO 10+30		Х	EROSION CONTROL TYPE 2		14,140		14,140	14,140	
EC-1	'PV' 14+09 TO 19+67		Х	EROSION CONTROL TYPE 2		21,360		21,360	21,360	
EC-2	'P' 11+03 TO 13+83		Х	EROSION CONTROL TYPE 2		6,395		6,395	6,395	
EC-2	'P' 12+33 TO 15+51	х		EROSION CONTROL TYPE 2		3.410		3.410	3.410	
EC-2	'P' – LINE	Х	Х	FIBER ROLLS						280
EC-1	'PV' – LINE	Х	Х	FIBER ROLLS						2,390
				TOTAL	198	82,380	198	82,578	82,380	2,670

#### <u>NOTE</u>

FIBER ROLLS SHALL BE PLACED ALONG TOP AND TOE OF CUT SLOPES AND SPACED EVERY 10' VERTICAL IN BETWEEN.

### <u>LEGEND</u>

COUNTY

딥

ENVIROMENTALLY SENSITIVE AREA FENCING. ALL TREES ALONG THE PERIMETER OF CONSTRUCTION MUST BE PROTECTED WITH ORANGE ESA FENCING, 1' OUTSIDE OF THE TREE DRIP LINE. ESA FENCING MAY BE PLACED AROUND ENTIRE CLUSTERS OR GROUPS OF TREES TO FORM ONE CONTINUOUSE PERIMETER. ANY ADDITIONAL TREES NOT DEPICTED ON THIS PLAN THAT LIE ADJACENT TO OR NEAR THE CONSTRUCTION AREA, MUST BE PROTECTED BY ESA FENCING.

ALL DISTURBED AREAS AND EXPOSED SLOPES SHALL HAVE HYDROMULCH AND HYDROSEED.

# **EROSION CONTROL (TYPE 1)**

SEQUENCE	ITEM	MATERIAL	APPLICATION RATE		
	DESCRIPTION	DESCRIPTION	TYPE	RAIL	
STEP 1	COMPOST	COMPOST	MEDIUM	2" DEPTH	
SIEP I	(TYPE 1)	SEED		45 LB/ACRE	
STEP 2	ROLLED EROSION CONTROL PRODUCT TRM (TYPE B)	NETTING	TYPE C		

DIST	COUNTY	ROUTE	POST MILES TOTAL PROJECT	SHEET NO.	TOTAL SHEETS
3	ED	49	10.6-10.9	42	46
REGI:		D. Anderson DIVIL ENGINEE L DATE	ER 2000 No.	ESS 10NA 5. ANDER	EAG   NEER
	NTY OF EL DO ERVILLE, CA.		-9 الله الله الله الله الله الله الله الل	SE Expires 30-14 /VIL CAL IFOR	
			OF-	CALI	

The state of California or its officers or agents shall not be responsible for the accuracy or completeness of electronic copies of this plan sheet

# **EROSION CONTROL (TYPE 2)**


SEQUENCE	ITEM	MATERIAL	APPLICATION		
OEGOENOE	DESCRIPTION	DESCRIPTION	TYPE	RATE	
STEP 1	EROSION CONTROL (BONDED FIBER	TACKIFIER	BONDED FIBER MATRIX	500 LB/ACRE	
	MATRIX)	SEED		45 LB/ACRE	
		FERTILIZER	ORGANIC	1200 LB/ACRE	
STEP 2	EROSION CONTROL (BONDED FIBER MATRIX)	TACKIFIER	BONDED FIBER MATRIX	3500 LB/ACRE	


# SEED MIX

BOTANICAL NAME (COMMON NAME)	PERCENT GERMINATION (MINIMUM)	POUNDS PURE LIVE SEED PER ACRE (SLOPE MEASUREMENT)
BROMUS CARINATUS <sup>1</sup> (CALIFORNIA BROME)	80	15
ESCHSHOLZIA CALIFORNICUM (CALIFORNIA POPPY)	75	3
HORDEUM B. CALIFORNICUM <sup>1</sup> (CALIFORNIA BARLEY)	80	9
LUPINUS BICOLOR <sup>1</sup> (PIGMY-LEAVED LUPINE)	80	9
NASSELLA PULCHRA <sup>1</sup> (PURPLE NEEDLEGRASS)	70	9
SEED PRODUCTED IN NORTHERN	N CALIFORNIA ONLY.	45

EROSION CONTROL/FENCING PLAN

EC-2 SCALE: 1"=40'

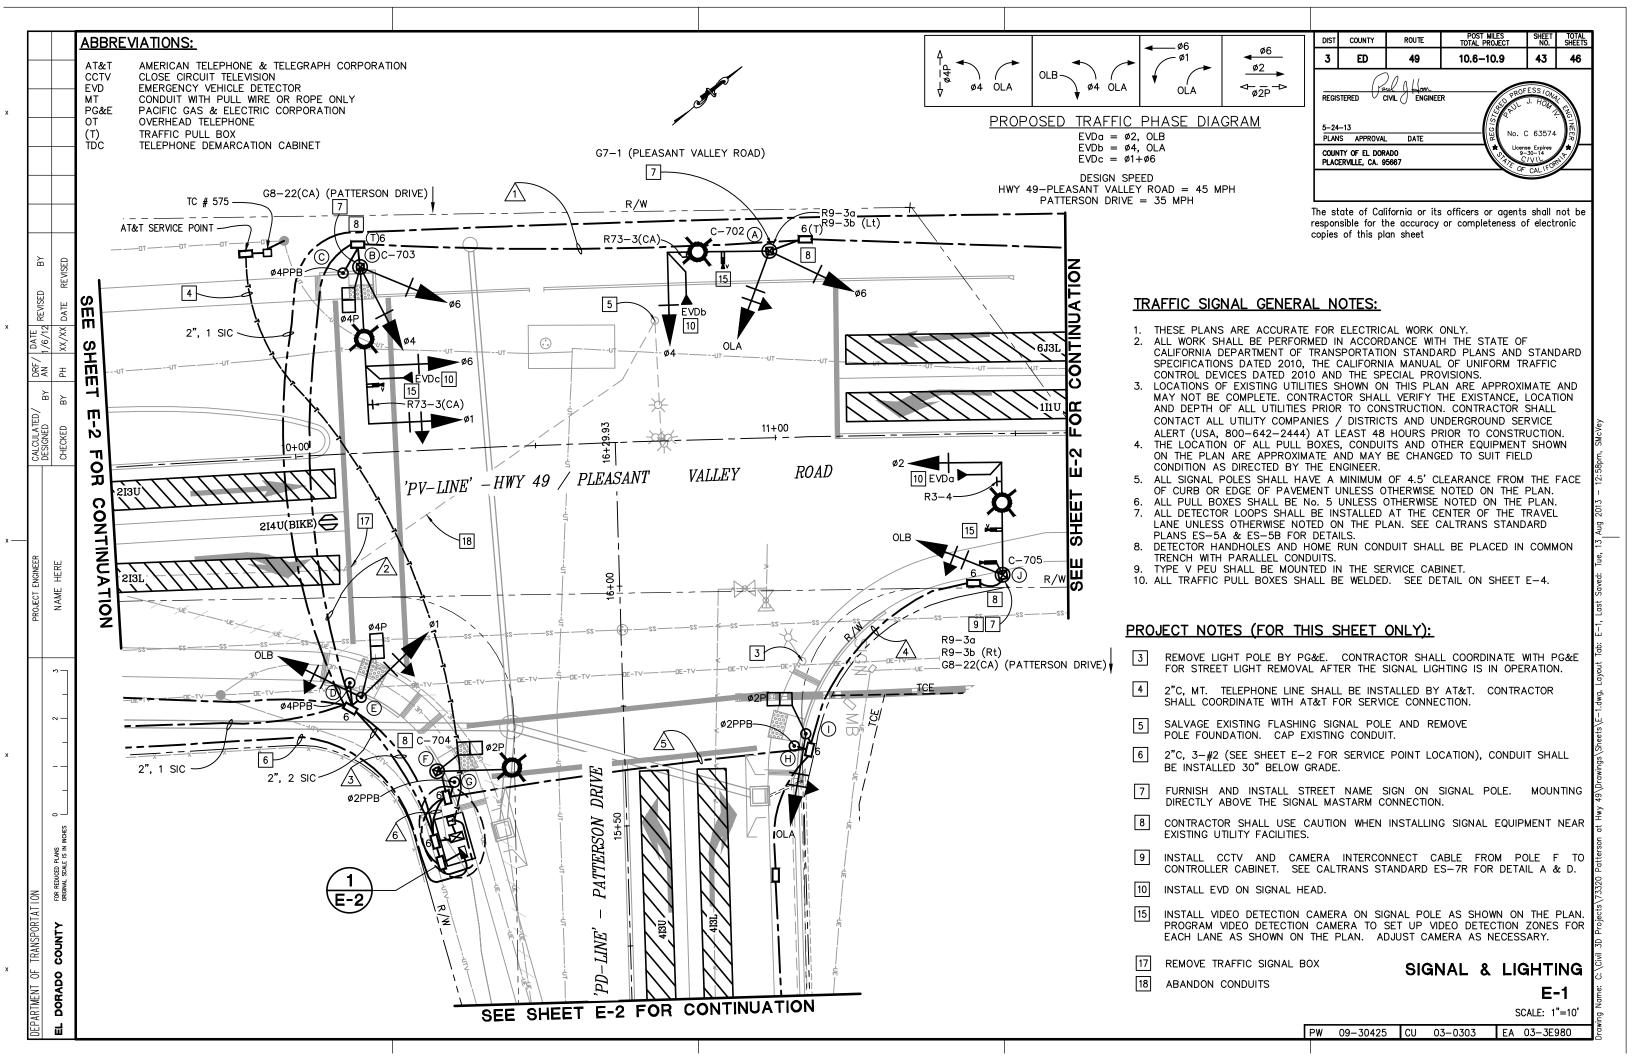

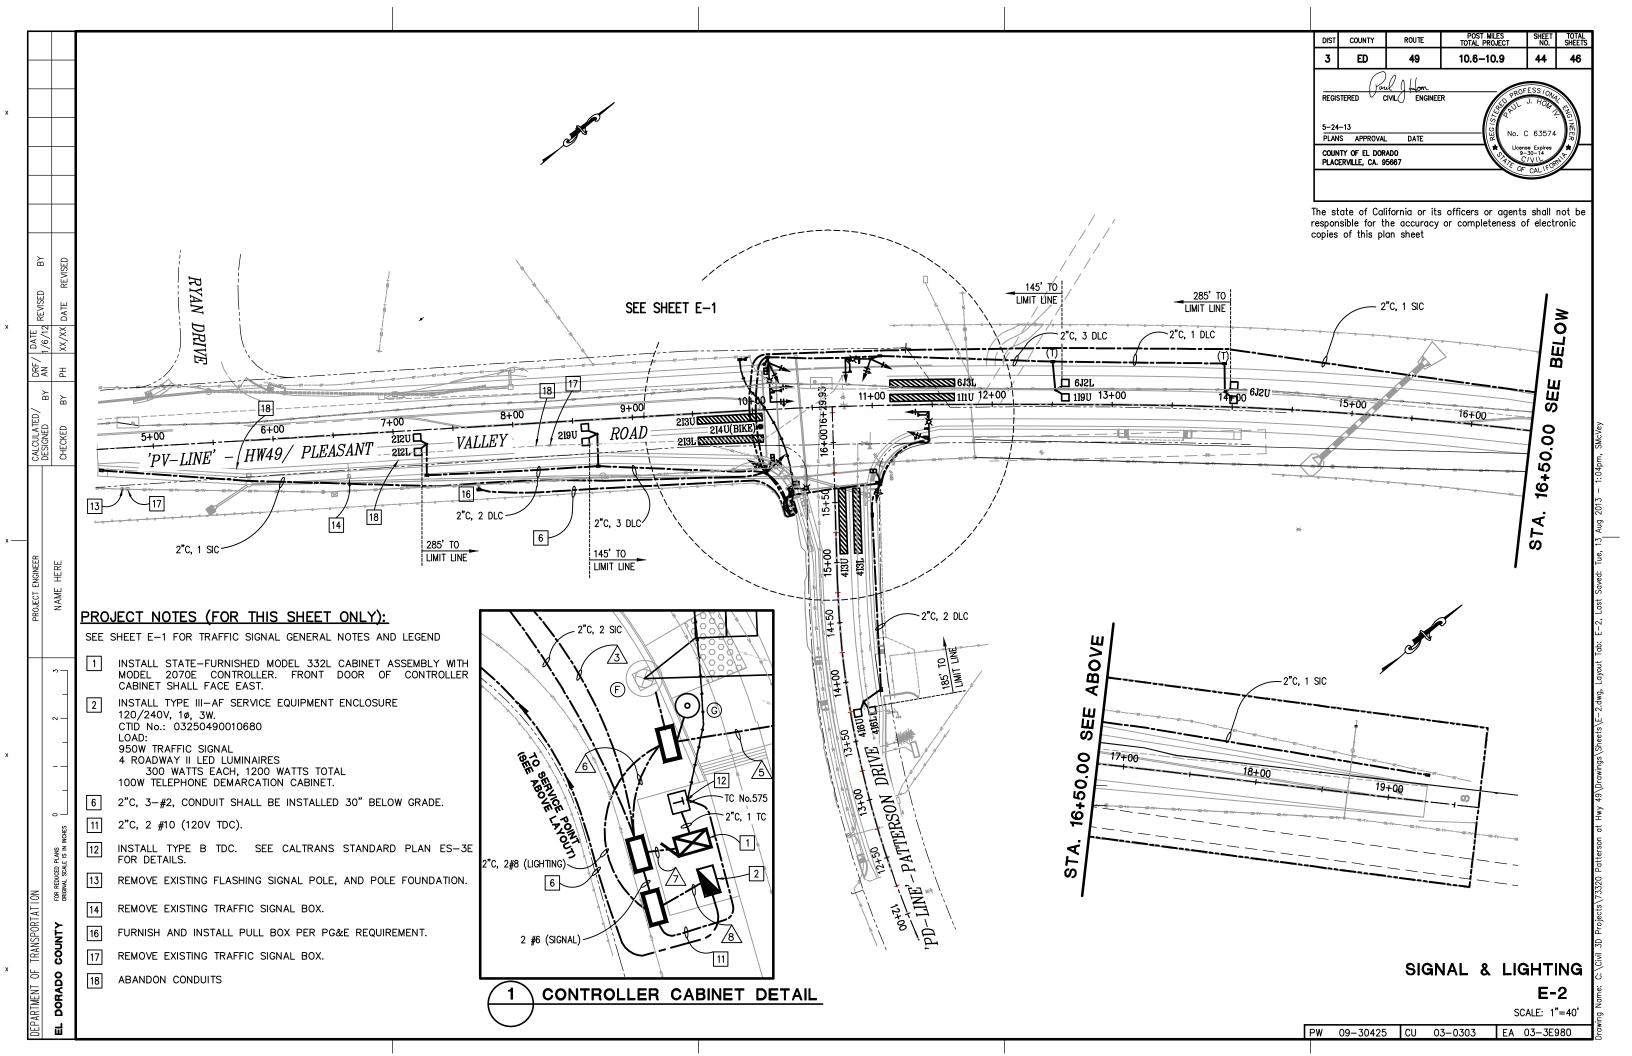

ARTMENT OF TRANSPORTATION         PROJECT ENGINEER         PROJECT ENGINEER         CALCULATED/PORTATION         DARF OFFICE			
NAME HERE CHECKED BY	ARTMENT OF TRANSPORTATION	PROJECT ENGINEER	
OHECKED BY			
	DORADO COUNTY FOR REDUCED PLANS 0 1 2 3 ORIGINAL SCALE IS IN INCHES 1 1 1 1 1	NAME HERE	

DOLE	VVID	<b>EQUIPMENT</b>	CULEDITIE
PULL	AIND	EUUIPMENI	SCHEDULE

	S	TANDARD			VEHICLE MOUI				TRIAN SIGNAL	F	PB	LED LUMINAIRE		LOCA	ATION	DEMARKS
NO.	TYPE	SIG. MA (FT)	LUM. MA (FT)	ø	MAST ARM	ø	POLE	ø	POLE	ø	ARROW	(WATTS)		STATION**	OFFSET	- RÆMARKS
A	19A-3-100	25	15	4	MAS	4	SV-2-TA					ROADWAY II	P	°V' 10+99.78	38.86' LT	- INSTALL EVDb ON SIGNAL HEAD. INSTALL R73−3(CA) ON SMA, & INSTALL R9−3α, R9−3b(Lt) ON STANDARD & INSTALL G7−1 (PLEASANT VALLEY ROAD) ON STANDARD WITH STRAP & SADDLE BRACKET METHOD ★
B	24A-4-100	35	15	1 6	MAS MAS	1 6	SV-2-TA	8	SP-1-T			ROADWAY II	'P	PV' 10+15.38	38.72' LT	- INSTALL EVD¢ ON SIGNAL HEAD. INSTALL R73-3(CA) ON SMA, & INSTALL G8-22(CA) (PATTERSON DRIVE) ON STANDARD WITH STRAP & SADDLE BRACKET METHOD F=12'. ★
0	PPB POST									8P	ļ		'F	PV' 10+11.84	38.17' LT	
0	PPB POST									8P	<b></b>		P	°V' 10+08.84	47.67' RT	
Œ	1-B						TV-2-T	8	SP-1-T				'F	PV' 10+11.13	50.83' RT	
(F)	15-TS		15					2	SP-1-T			ROADWAY II	P	°V' 10+26.43	66.95' RT	
©	PPB POST									2P	-		P	°V' 10+27.90	69.68' RT	
$\oplus$	PPB POST									2P	1		'P	PV' 11+04.20	66.95' RT	
①	1-B						TV-1-T	2					'P	PV' 11+04.80	61.84' RT	
<u> </u>	19A-3-100	25	15	2	MAS	2	SV-1-T		SP-1-T			ROADWAY II	'P	PV 11+47.02	29.48' RT	INSTALL EVDG ON SIGNAL HEAD. INSTALL R3-4 ON SMA, & INSTALL R9-3G, R9-3b (Rt) ON STANDARD, & G8-22(CA) (PATTERSON DRIVE) ON STANDARD WITH STRAP & SADDLE BRACKET METHOD *

DIST COUNTY ROUTE POST MILES SHEET TOTAL PROJECT NO. SHEETS  3 ED 49 10.6–10.9 45 46  REGISTERED CIVIL ENGINEER  5-24–13 PLANS APPROVAL DATE  COUNTY OF EL DORADO PLACERVILLE, CA. 95667						
REGISTERED CIVIL ENGINEER  5-24-13 PLANS APPROVAL DATE  COUNTY OF EL DORADO	DIST	COUNTY	ROUTE		SHEET NO.	TOTAL SHEETS
5-24-13 PLANS APPROVAL DATE  COUNTY OF EL DORADO	3	ED	49	10.6-10.9	45	46
	5-24 PLAN	–13 IS APPROVAL	_ DATE	No. (C	63574 E Expires 30-14	ENG (NEER

The state of California or its officers or agents shall not be responsible for the accuracy or completeness of electronic copies of this plan sheet

# OTHER REQUIREMENTS ARE COVERED BY NOTES, LEGEND, SPECIAL PROVISIONS AND STANDARD SPECIFICATIONS. FOR TYPE OF STANDARD AND VEHICLE SIGNAL MOUNTING, SEE STANDARD PLANS.

\*\* THE FINAL LOCATION WILL BE DETERMINED BY FIELD ENGINEERS.


	CON	IDUC	TOI	R & C	ONDUI	T SCH	EDULE					
				RUN No.								
AWG SIZE OR		POLE	ΩR	NEW	NEW	NEW	NEW	NEW	NEW	NEW	NEW	
CABLE TYPE	PHASE Ø	CIRC			<u>^</u>	3	4	_5	<u>6</u>	$\triangle$	8	
	4, 6, OLA	POLE	A	1	1	1				1		
	1, 4, 6, 4P	POLE	B		1	1				1		
	4PPB	POLE	0		1	1				1		
	4PPB	POLE	0			1				1		
12/3	1, 4P, OLB	POLE	E			1				1		
CONDUCTOR	2P	POLE	(F)						1	1		
SIGNAL CABLES	2PPB	POLE	<b>©</b>						1	1		
ONDEES	2PPB	POLE	$\oplus$					1	1	1		
	2P, OLA	POLE	(1)					1	1	1		
	2, OLB	POLE	<u>(J)</u>				1	1	1	1		
TOTAL	CABLES 12/3 CONDUCTORS	5		1	2/1	3 2	1	2 1	3 2	6 4		
<b>#</b> 10	TDC										2	
<b>#</b> 8	LIGHTING			2	2	2	2	2	2		2	
<i>"</i> -	SIGNAL			2	2	2	2	2	2		2	
<b>#</b> 6	CONTROLLER SERVI	CE								2	2	
	ø1			1	1	1				1		
TYPE B	ø2					3				3		
DĽC	ø4							2	2	2		
	ø6			2	2	2				2		
	TOTAL			3	3	6		2	2	8		
	VIDEO DETECTOR CABLE			1	1	1	1	1	1	2		
	EVC	1	2	2	1	1	1	3				
	CAMERA INTERCONNECT CA				1	1	1	1				
	SIC	1	1	2				2				
CONDU	IT SIZE	1-3"	1-4"	1-4"	2-2"	1-3"	1-4"	2-4"	1-2"			
			1-2"	1-2"	2-2"		1-2"	1-2"	3-2"			
% FILL				16	15	21	28	23	17	19	10	

## NOTES:

- 1. CAMERA INTERCONNECT CABLE PLACED IN 1-2"C BY ITSELF.
- 2. SIGNAL INTERCONNECT CABLE PLACED IN 1-2" BY ITSELF.

SIGNAL & LIGHTING

E-3 SCALE: N/A

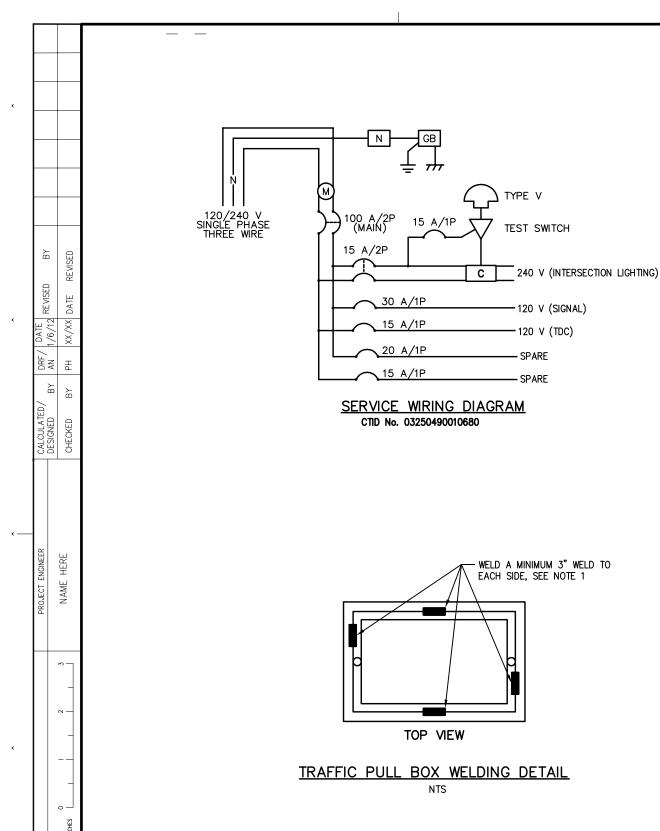

DORADO

### WIRING DIAGRAM SYMBOLS

C CONTACTOR (LIGHTING)

GB GROUND BUS


NEUTRAL

AUTO-TEST SWITCH

PHOTOELECTRIC UNIT

METER SOCKET WITH MANUAL CIRCUIT CLOSING DEVICE

- 1. WELDING MUST COMPLY WITH STANDARD SPECIFICATION SECTION 75.
- CONDUITS ENTERING THE PULL BOX MUST BE ENCASED IN PCC (3" ALL AROUND). PCC ENCASEMENT MUST EXTEND 5'-6" FROM THE PULL BOX.
- PULL BOXES FOR ELECTROLIERS, POST AND SIGNAL STANDARDS MUST BE LOCATED WITHIN 5'-0" FROM THE STATION OF THE ADJACENT ELECTROLIER, POST OR SIGNAL STANDARD.

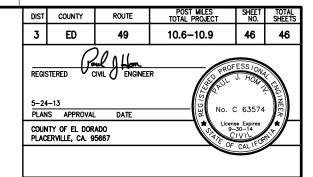

The state of California or its officers or agents shall not be responsible for the accuracy or completeness of electronic copies of this plan sheet

SIGNAL & LIGHTING

E-4

SCALE: N/A

PW 09-30425 CU 03-0303 EA 03-3E980

# NOTES ON PULL BOXES: